


TYP. STUD WALL TO LOG WALL CONNECTION @ INTERIOR 2x6 STUD WALL NOT TO SCALE

REF K

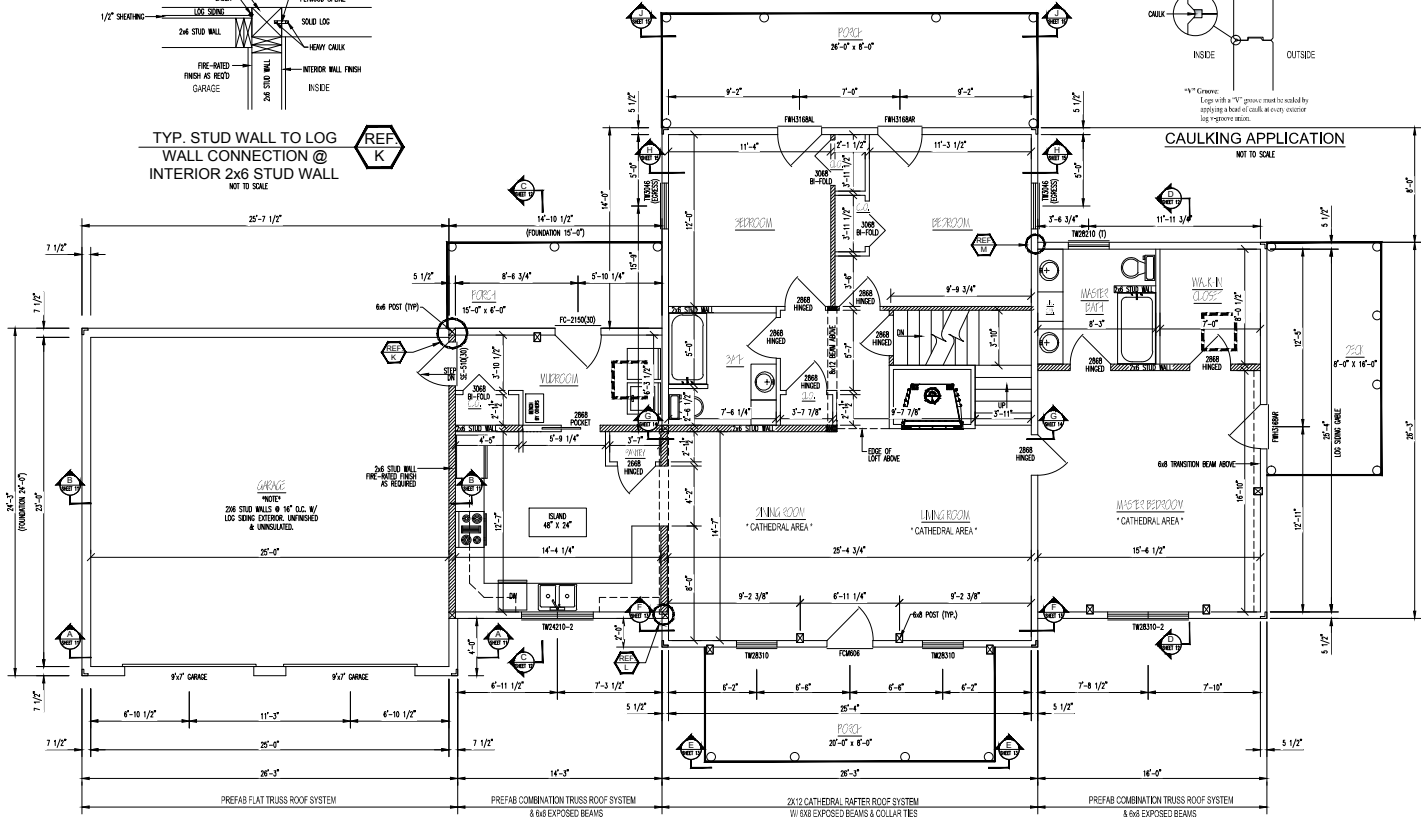

1st LEVEL FLOOR PLAN

- INDICATES BEARING WALLS


TOTAL FLOOR SPACE = 1652 SQ. FT.

TOTAL GARAGE SPACE = 614 SQ. FT.

INTERIOR FASTENERS	
3/8" x 6" LAGS	PARTITION WALLS TO LOG WALL CONNECTION
16d CEMENT COATED SINKERS	CONVENTIONAL FRAMING
16d FINISH NAILS	INTERIOR DOOR JAMBS
8d FINISH NAILS	INTERIOR TRIM
6d FINISH NAILS	1x6 T&G WALL FINISH


  

FLOOR PLAN GENERAL NOTES	
<b>GENERAL SPECIFICATIONS</b> SEE COVER SHEET.	
<b>DETAILS</b> REFER TO APPLICABLE DETAILS FOR FLOOR PLAN INFORMATION	
<b>INTERIOR PARTITION HEIGHTS</b> REFER TO SECTIONS FOR APPROPRIATE LOG COURSE HEIGHT. FINAL HEIGHT DETERMINED BY ACTUAL LOG COURSE STACK HEIGHT.	
<b>MULLED WINDOWS</b> WINDOWS MAY NEED MULLED ON SITE DUE TO SIZE OR TYPE.	
<b>DETAILS</b> ALL DETAIL REFERENCES NOT NOTED ARE FOUND WITHIN THE DETAIL SHEETS AND TIMBERHAVEN CONSTRUCTION MANUAL. PLEASE REFER TO THE OTHER SHEETS AND MANUAL, TYPICAL.	
<b>MATERIALS INCLUDED</b> ALL DETAILS PERTAINING TO MATERIAL NOT SUPPLIED BY TLH MUST BE VERIFIED PRIOR TO ACTUAL CONSTRUCTION. SEE APPROPRIATE QUOTE AND ALL APPLICABLE CHANGE ORDERS FOR MATERIALS TO BE SUPPLIED BY TLH.	

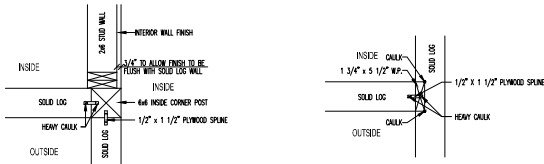

TYP. INSIDE CORNER POST CONNECTION NOT TO SCALE


REF L

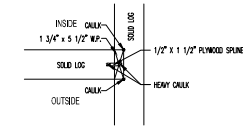

TYP. LOG WALL TO LOG WALL CONNECTION NOT TO SCALE


REF M

CAULKING APPLICATION NOT TO SCALE

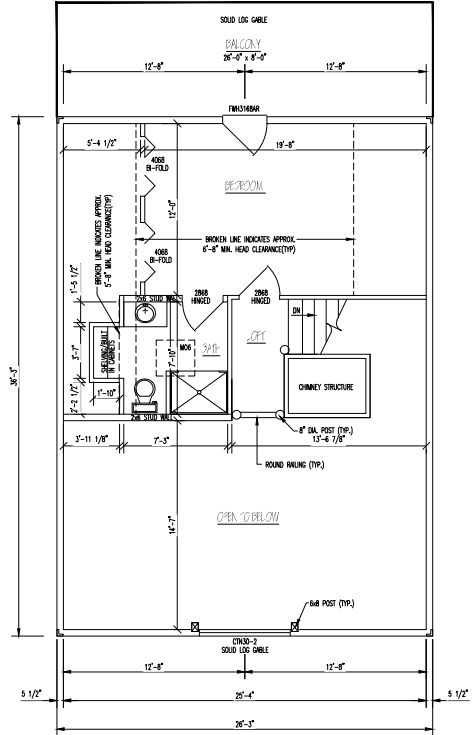

2nd LEVEL FLOOR PLAN

TOTAL FLOOR SPACE = 434 SQ. FT.

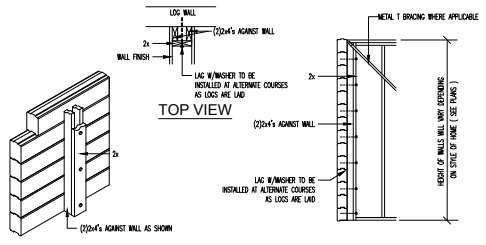

TYP. CONNECTION OF INTERIOR WALLS TO LOG WALLS (MAY BE 2x4 OR 2x6 SEE PLAN) NOT TO SCALE

COPYRIGHT NOTICE © Copyright 2015 by Timberhaven Log Homes  
DO NOT SCALE DRAWING - CONTRACTOR TO VERIFY ALL DIMENSIONS IN FIELD

RESPONSE FOR:			
LOU LIFRERI / ROARING BROOK LOG HOMES LLC			
PLAN NAME	FLOOR PLANS	FINAL SHEET	DATE: 07/15/16
PREPARED BY: MEZ	DATE: 6/23/16	DRAWN BY: MEZ	SCALE: 1/4" = 1'-0"
CHECKED BY: MEZ	DATE:	DESIGNED BY: MEZ	PROJECT NO.: TLH-10189-1
APPROVED BY: MEZ	DATE:	SALES REP.:	DATE: 11/10/15-1
DATE:		QUANTITY:	SHEET NO. 3 OF 15
TIMBERHAVEN			